



DEPARTMENT OF PERMITTING, ENVIRONMENT, AND REGULATORY  
AFFAIRS (PERA)  
BOARD AND CODE ADMINISTRATION DIVISION

## NOTICE OF ACCEPTANCE (NOA)

MIAMI-DADE COUNTY  
PRODUCT CONTROL SECTION  
11805 SW 26 Street, Room 208  
Miami, Florida 33175-2474  
T (786) 315-2590 F (786) 315-2599  
[www.miamidade.gov/pera/](http://www.miamidade.gov/pera/)

**HWD Acquisition, Inc. dba Hurd Windows & Doors**  
575 South Whelen Avenue  
Medford, WI 54451

### SCOPE:

This NOA is being issued under the applicable rules and regulations governing the use of construction materials. The documentation submitted has been reviewed and accepted by Miami-Dade County PERA - Product Control Section to be used in Miami Dade County and other areas where allowed by the Authority Having Jurisdiction (AHJ).

This NOA shall not be valid after the expiration date stated below. The Miami-Dade County Product Control Section (In Miami Dade County) and/or the AHJ (in areas other than Miami Dade County) reserve the right to have this product or material tested for quality assurance purposes. If this product or material fails to perform in the accepted manner, the manufacturer will incur the expense of such testing and the AHJ may immediately revoke, modify, or suspend the use of such product or material within their jurisdiction. PERA reserves the right to revoke this acceptance, if it is determined by Miami-Dade County Product Control Section that this product or material fails to meet the requirements of the applicable building code.

This product is approved as described herein, and has been designed to comply with the Florida Building Code, including the High Velocity Hurricane Zone.

### DESCRIPTION: Series "Feel Safe" Outswing Aluminum Clad Wood Casement Window – L.M.I.

**APPROVAL DOCUMENT:** Drawing No. 1403, titled "Feel Safe Aluminum Clad Wood Impact Operable Casement Window, sheets 1 through 6 of 6, dated 07/21/05, with revision C1 dated 10/04/11, prepared by W. W. Schaefer Engineering & Consulting, P.A., signed and sealed by Warren W. Schaefer, P.E., bearing the Miami-Dade County Product Control Revision stamp with the Notice of Acceptance number and expiration date by the Miami-Dade County Product Control Section.

### MISSILE IMPACT RATING: Large and Small Missile Impact Resistant

**LABELING:** Each unit shall bear a permanent label with the manufacturer's name or logo, city, state, model/series, and following statement: "Miami-Dade County Product Control Approved", unless otherwise noted herein.

**RENEWAL** of this NOA shall be considered after a renewal application has been filed and there has been no change in the applicable building code negatively affecting the performance of this product.

**TERMINATION** of this NOA will occur after the expiration date or if there has been a revision or change in the materials, use, and/or manufacture of the product or process. Misuse of this NOA as an endorsement of any product, for sales, advertising or any other purposes shall automatically terminate this NOA. Failure to comply with any section of this NOA shall be cause for termination and removal of NOA.

**ADVERTISEMENT:** The NOA number preceded by the words Miami-Dade County, Florida, and followed by the expiration date may be displayed in advertising literature. If any portion of the NOA is displayed, then it shall be done in its entirety.

**INSPECTION:** A copy of this entire NOA shall be provided to the user by the manufacturer or its distributors and shall be available for inspection at the job site at the request of the Building Official.

This NOA revises NOA # 11-0517.02 and consists of this page 1 and evidence pages E-1 and E-2, as well as approval document mentioned above.

The submitted documentation was reviewed by **Manuel Perez, P.E.**



NOA No. 11-1006.05  
Expiration Date: June 29, 2016  
Approval Date: November 17, 2011  
Page 1


**NOTICE OF ACCEPTANCE: EVIDENCE SUBMITTED**

**A. DRAWINGS**

1. Manufacturer's die drawings and sections.
2. Drawing No **1403**, titled "Feel Safe Aluminum Clad Wood Impact Operable Casement Window, Sheets 1 through 6 of 6, dated 7/21/05, with revision C1 dated 10/04/11, prepared by W. W. Schaefer Engineering & Consulting, P.A., signed and sealed by Warren W. Schaefer, P.E.

**B. TESTS**

1. Test reports on: 1) Air Infiltration Test, per FBC, TAS 202-94  
2) Uniform Static Air Pressure Test, Loading per FBC TAS 202-94  
3) Water Resistance Test, per FBC, TAS 202-94  
4) Large Missile Impact Test per FBC, TAS 201-94  
5) Cyclic Wind Pressure Loading per FBC, TAS 203-94  
along with marked-up drawings and installation diagram of an aluminum clad wood casement window, prepared by Stork Twin City Testing Corporation, Test Report No. **STCTC-180-7776.1** dated 03/04/09, signed and sealed by Tom Kolden, P.E.  
*(Submitted under previous NOA #09-0714.05)*
2. Test Report on: 1) Air Infiltration Test, per FBC, TAS 202-94  
2) Uniform Static Air Pressure Test, Loading per FBC TAS 202-94  
3) Water Resistance Test, per FBC, TAS 202-94  
4) Large Missile Impact Test per FBC, TAS 201-94  
5) Cyclic Wind Pressure Loading per FBC, TAS 203-94  
along with marked-up drawings and installation diagram of an aluminum clad wood casement window, prepared by Stork Twin City Testing Corporation, Test Report No. **STCTC-180-7705.1** dated 11/07/09, signed and sealed by Tom Kolden, P.E.  
*(Submitted under previous NOA #09-0714.05)*
3. Test reports on: 1) Air Infiltration Test, per FBC, TAS 202-94  
2) Uniform Static Air Pressure Test, Loading per FBC, TAS 202-94  
3) Water Resistance Test, per FBC, TAS 202-94  
4) Large Missile Impact Test per FBC, TAS 201-94  
5) Cyclic Wind Pressure Loading per FBC, TAS 203-94  
along with marked-up drawings and installation diagram of 6 specimens each consisting of three-panel configuration of aluminum clad casement windows, prepared by Architectural Testing, Inc., Test Report No. **ATI-60529.01-602-18**, dated 10/11-14/05, signed and sealed by Joseph A. Reed, P.E.  
*(Submitted under previous NOA #06-0130.03)*

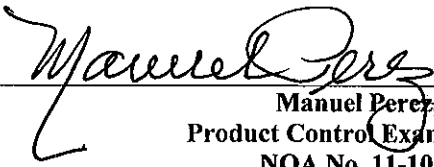  
Manuel Perez, P.E.  
Product Control Examiner  
NOA No. 11-1006.05  
Expiration Date: June 29, 2016  
Approval Date: November 17, 2011

**NOTICE OF ACCEPTANCE: EVIDENCE SUBMITTED**

**B. TESTS (CONTINUED)**

4. Test reports on: 1) Air Infiltration Test, per FBC, TAS 202-94  
2) Uniform Static Air Pressure Test, Loading per FBC, TAS 202-94  
3) Water Resistance Test, per FBC, TAS 202-94  
4) Forced Entry Test, per FBC 2411 3.2.1 and TAS 202-94  
5) Cyclic Wind Pressure Loading per FBC, TAS 203-94  
along with marked-up drawings and installation diagram of 6 specimens each consisting of three-panel configuration of aluminum clad casement windows, prepared by Architectural Testing, Inc., Test Report No. **ATI-522274.04-602.18**, dated 07/28/04, signed and sealed by Joseph A. Reed, P.E.  
*(Submitted under previous NOA #06-0130.03)*

**C. CALCULATIONS:**

1. Anchor Calculations and structural analysis, complying with FBC-2007 and FBC-2010, prepared by W. W. Schaefer Engineering & Consulting, P.A., dated 06/29/09, 05/12/11, and 10/04/11, signed and sealed by Warren W. Schaefer, P.E.  
2. Glazing complies with ASTM E1300-04.

**D. QUALITY ASSURANCE**

1. Miami-Dade Department of Permitting, Environment, and Regulatory Affairs (PERA).

**E. MATERIAL CERTIFICATIONS**

1. Notice of Acceptance No. **08-1118.07** issued to **Oldcastle Glass Inc.** for their "StormGlass Glass Interlayer", dated 03/05/09, expiring on 12/11/13.  
2. Notice of Acceptance No. **09-0223.05** issued to **Solutia, Inc.** for their "Saflex Multi-layer Glass Interlayer" dated 04/08/09, expiring on 04/08/14.

**F. STATEMENTS**

1. Statement letter of conformance to the FBC-2010, dated 10/04/11, signed and sealed by Warren W. Schaefer, P.E.  
2. Statement letter of no financial interest, dated 10/04/11, signed and sealed by Warren W. Schaefer, P.E.

**G. OTHERS**

1. Notice of Acceptance No. **11-0517.02**, issued to HWD Acquisition, Inc. dba Hurd Windows & Doors for their Series "Feel Safe" Outswing Aluminum Clad Wood Casement Window – L.M.I., approved on 07/14/11 and expiring on 06/29/16.

### GENERAL NOTES:

1. THESE WINDOW SYSTEMS HAVE BEEN TESTED, ANALYZED & APPROVED FOR DESIGN PRESSURES NOT TO EXCEED THOSE SHOWN IN THE "ALLOWABLE DESIGN PRESSURE TABLE(S)".
2. OPENINGS, BUCKING & BUCKING FASTENERS MUST BE PROPERLY DESIGNED & INSTALLED TO TRANSFER WIND LOADS TO THE STRUCTURE.
3. ALL HARDWARE & FASTENERS SHALL BE IN ACCORDANCE WITH THESE DRAWINGS & SHALL NOT VARY UNLESS SPECIFICALLY MENTIONED ON THE DRAWINGS. SPECIFIED ANCHOR EMBED TO BASE MATERIAL SHALL BE BEYOND WALL FINISH OR STUCCO.
4. THE DETAILS & SPECIFICATIONS SHOWN HEREIN REPRESENT THE PRODUCTS TESTED & PROPOSED FOR WATER, AIR, IMPACT, CYCLIC & UNIFORM STATIC AIR PRESSURE TESTING IN CONFORMANCE WITH THE FLORIDA BUILDING CODE PROTOCOLS TAS-201, 202 & 203 FOR LARGE MISSILE IMPACT WINDOWS.
5. THESE WINDOW SYSTEMS HAVE BEEN DESIGNED IN ACCORDANCE WITH AND MEET THE REQUIREMENTS OF THE FLORIDA BUILDING CODE (FBC) INCLUDING HIGH VELOCITY HURRICANE ZONES (HVHZ).
6. IMPACT SHUTTERS ARE NOT REQUIRED WITH THESE WINDOWS.
7. ALL ANCHORS SECURING WINDOW FRAME TO PRESSURE TREATED BUCKS OR WOOD FRAMING SHALL BE CAPABLE OF RESISTING CORROSION CAUSED BY THE PRESSURE TREATING CHEMICALS IN THE WOOD.
8. DETERMINE THE POSITIVE & NEGATIVE DESIGN LOADS TO USE WHEN REFERENCING THESE DOCUMENTS IN ACCORDANCE WITH THE GOVERNING CODE AND GOVERNING WIND VELOCITY. FOR WIND LOAD CALCULATIONS IN ACCORDANCE WITH THE FLORIDA BUILDING CODE, A DIRECTIONALITY FACTOR OF  $K_d = 0.85$  MAY BE APPLIED PER THE ASCE-7 STANDARD.
9. NO INCREASE IN ALLOWABLE STRESS HAS BEEN USED IN THE CERTIFICATION OF THIS PRODUCT. WIND LOAD DURATION FACTOR  $C_d = 1.6$  WAS USED FOR WOOD SCREW ANALYSIS ONLY.
10. MATERIALS, INCLUDING BUT NOT LIMITED TO STEEL SCREWS, THAT COME INTO CONTACT WITH OTHER DISSIMILAR MATERIALS SHALL MEET THE REQUIREMENTS OF FLORIDA BUILDING CODE CHAPTER 20.
11. ALL WOOD MEMBERS OF WINDOWS THAT MAY POSSIBLY COME INTO CONTACT WITH MASONRY OR CONCRETE SUBSTRATES, ARE SUBJECT TO MOISTURE &/OR ARE SUBJECT TO THE OUTSIDE ENVIRONMENT SHALL BE OF AN APPROVED DURABLE SPECIES OR BE TREATED IN AN APPROVED METHOD WITH AN APPROVED PRESERVATIVE PER FBC SECTION 2326.

### CORNER CONSTRUCTION:

**WOOD FRAME:** SQUARE CUT, RABBETED, SILICONE SEALED & SECURED WITH THREE (3) 16 GA. X 1/2" X 2" CROWN STAPLES.

**FRAME CLAD:** MITER CUT, JOINED WITH A CORNER KEY & TWO (2) NO. 7 X 1/2" SCREWS & SEALED WITH A FOAM GASKET.

**WOOD SASH:** MORTISE & TENON CONSTRUCTION AND SECURED WITH TWO (2) 14 GA. X 2 1/2" T-NAILS.

**SASH CLAD:** SQUARE CUT, BUTTED TOGETHER AND SNAP FIT TO SASH AND SEALED WITH SILICONE.


LOCK REQUIREMENTS	
MAX. FRAME HEIGHT	NO. OF LOCK STRIKES
72 3/16"	5
60 3/16"	4
48 3/16"	3
32 3/16" & LESS	2

SNUBBER REQUIREMENTS	
MAX. FRAME HEIGHT	NO. OF SNUBBERS REQUIRED
72 3/16"	4
53 3/16"	3
34 3/16" & LESS	2


### FRAME ANCHOR REQUIREMENTS TABLE

OPENING TYPE (SUBSTRATE)	FRAME/FIN TO OPENING FASTENER TYPE	MINIMUM EMBED	MINIMUM EDGE DIST.
FRAME SCREWS			
MIN. 2X4 WOOD FRAME OR BUCK (MIN. GR. 3 & G=0.55)	NO. 10 SMS OR WOOD SCREW	1 1/4"	3/4"
MIN. 18 GA. 33 KSI METAL STUD	NO. 10 GR. 5 SELF TAP/DRILL SCREW	FULL	1/2"
MIN. 1/8" THK A36 STEEL	NO. 10 GR. 5 SELF TAP/DRILL SCREW	FULL	1/2"
MIN. 1/8" THK 6063-T5 ALUM.	NO. 10 GR. 5 SELF TAP/DRILL SCREW	FULL	1/2"
C-90 CMU/2500 PSI CONCRETE	(1) 1/4" CONCRETE SCREW	1 1/4"	2"
(2) NAILING FIN FASTENERS			
MIN. 2X4 WOOD FRAME OR BUCK (MIN. GR. 3 & G=0.55)	NO. 8 SMS SCREW	1 1/8"	1/2"
MIN. 2X4 WOOD FRAME OR BUCK (MIN. GR. 3 & G=0.55)	11 GA. ROOFING NAIL	1 3/4"	1/2"
MIN. 1/8" THK A36 STEEL	NO. 8 GR. 5 SELF TAP/DRILL SCREW	FULL	1/2"
MIN. 1/8" THK 6063-T5 ALUM.	NO. 8 GR. 5 SELF TAP/DRILL SCREW	FULL	1/2"

- (1) CONCRETE SCREWS SHALL BE ELCO ULTRACONS, ITW RAMSET/RED HEAD TAPCONS, HILTI KWIK-CON II OR POWERS RAWL TAPPER (HARDENED STEEL OR S.S.).
- (2) NAIL FIN SCREWS SHALL BE A PAN HEAD OR HEX HEAD SCREW OR HAVE A FLAT WASHER AT THE SCREW HEAD.

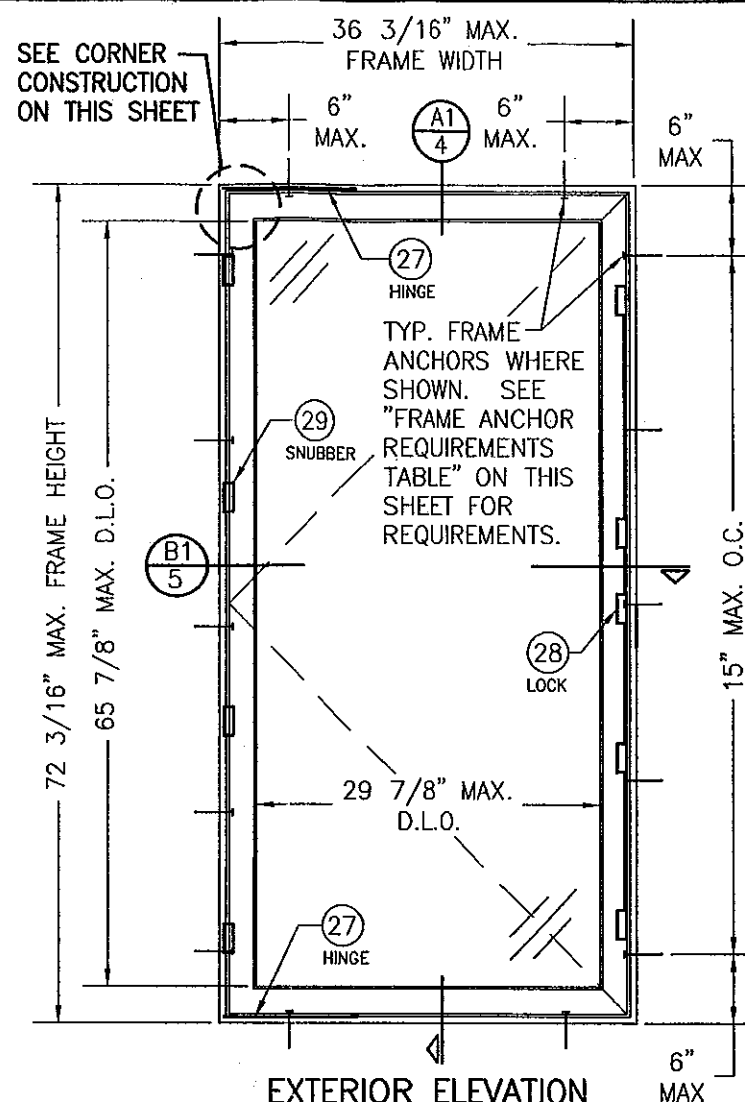

EXTERIOR ELEVATION  
SINGLE WINDOW  
(FRAME SCREW MOUNT)  
SCALE: 3/4"=1'-0"

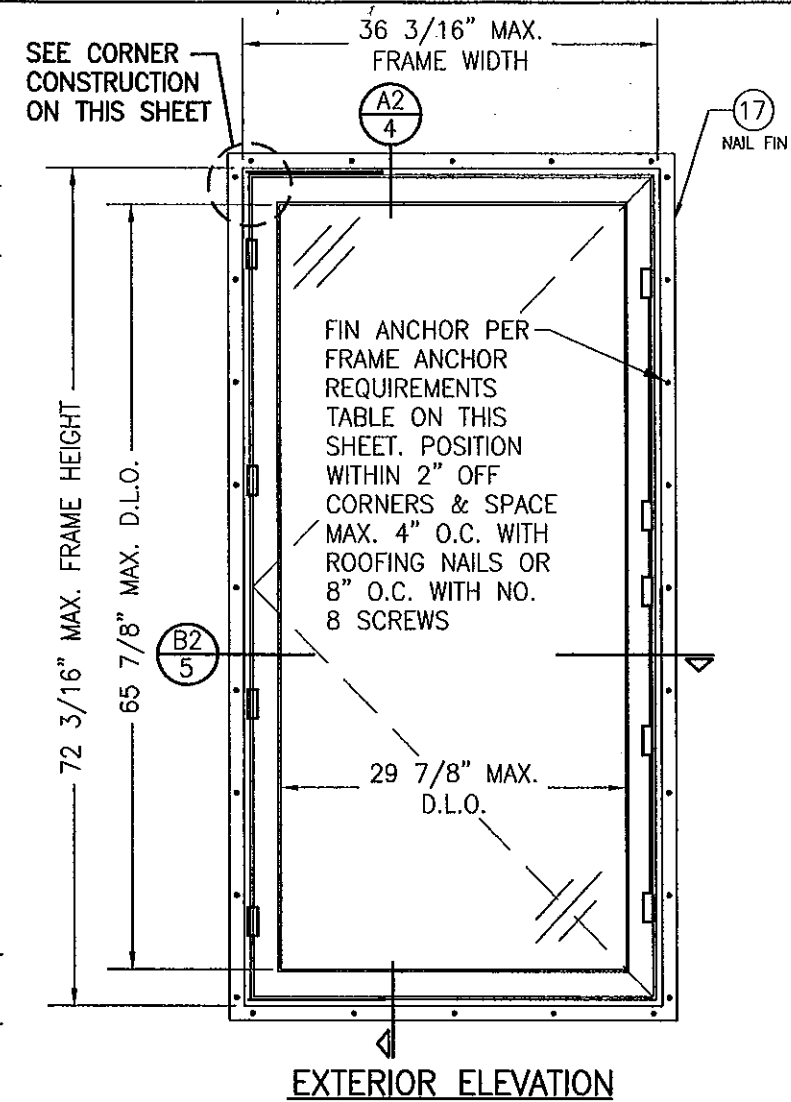

EXTERIOR ELEVATION  
SINGLE WINDOW  
(FIN MOUNT)  
SCALE: 3/4"=1'-0"

FOR INFORMATION NOT SHOWN, SEE FRAME SCREW MOUNTED SINGLE WINDOW ELEVATION

### ALLOWABLE DESIGN PRESSURE (SINGLE WINDOWS)


GLASS OPTION	MAXIMUM FRAME WIDTH (IN.)	MAXIMUM FRAME HEIGHT (IN.)	ALLOWABLE PRESSURE	
			POSITIVE (PSF)	NEGATIVE (PSF)
1	36 3/16	72 3/16	65	70
2 & 3	36 3/16	60 3/16	65	85
4	36 3/16	72 3/16	65	65
4	32 3/16	72 3/16	65	70
4	36 3/16	68 3/16	65	70

SEE GLAZING DETAILS FOR GLASS OPTIONS

PRODUCT REVISED  
as complying with the Florida  
Building Code  
Acceptance No 11-1006-05  
Expiration Date June 29, 2016  
By *Manuel Perez*  
Miami Dade Product Control



DRAWN BY: S.T.R.	CHECKED BY: W.W.S.
PLOT: 1=16	DATE: 7/21/05
DATE 06/29/09	DATE 06/29/11
BY WRM	BY WRM
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REVISION DESCRIPTION ADD TWIN WINDOW WITH TRANSOM	REVISION DESCRIPTION CHANGE MANUFACTURER NAME
NO. A1	NO. B1
DATE 06/29/09	DATE 10/04/11
BY WRM	BY WRM
REVISION DESCRIPTION CONSTRUCTION	REVISION DESCRIPTION UPDATE CONSULTANT ADDRESS
NO. A1	NO. C1
DATE 06/29/09	DATE 10/04/11
BY WRM	BY WRM
REVISION DESCRIPTION ADD TWIN WINDOW WITH TRANSOM	REVISION DESCRIPTION CHANGE MANUFACTURER NAME
NO. A1	NO. B1
DATE 06/29/09	DATE 10/04/11
BY WRM	BY WRM
REVISION DESCRIPTION CONSTRUCTION	REVISION DESCRIPTION UPDATE CONSULTANT ADDRESS
NO. A1	NO. C1
DATE 06/29/09	DATE 10/04/11
BY WRM	BY WRM
REVISION DESCRIPTION ADD TWIN WINDOW WITH TRANSOM	REVISION DESCRIPTION CHANGE MANUFACTURER NAME
NO. A1	NO. B1
DATE 06/29/09	DATE 10/04/11
BY WRM	BY WRM
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NO. A1	NO. C1
DATE 06/29/09	DATE 10/04/11
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REVISION DESCRIPTION ADD TWIN WINDOW WITH TRANSOM	REVISION DESCRIPTION CHANGE MANUFACTURER NAME

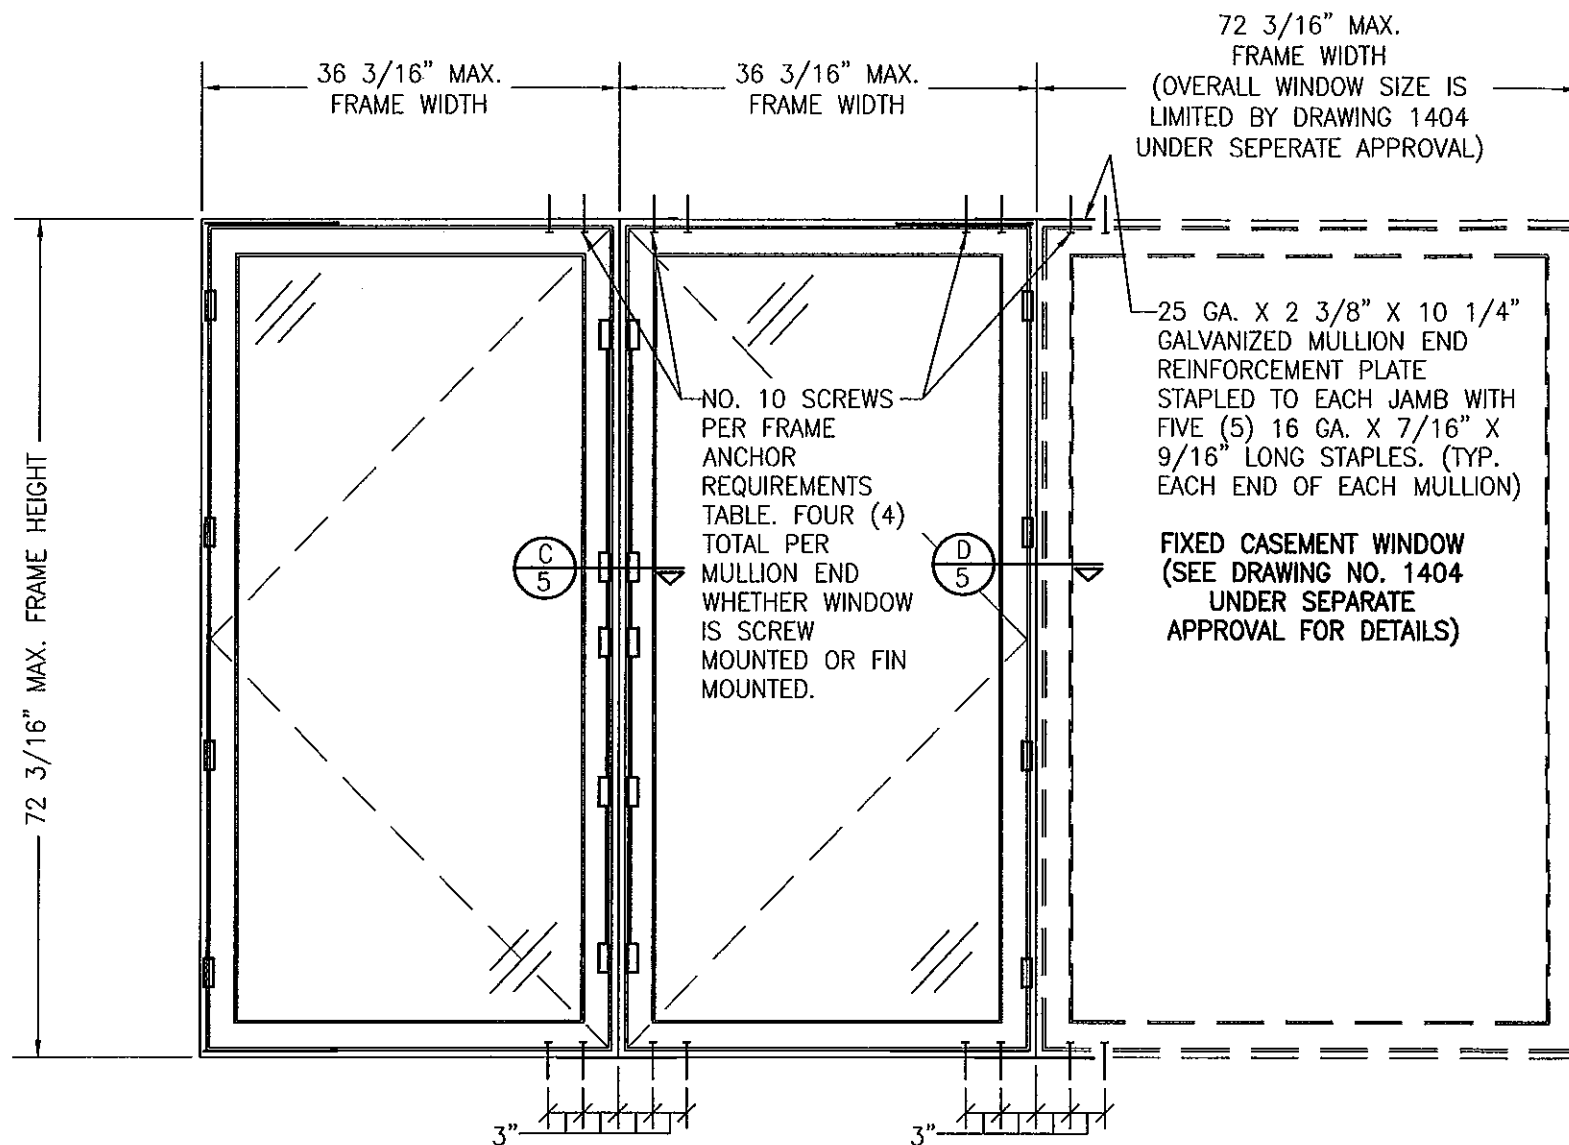


**EXTERIOR ELEVATION  
MULTIPLE SIDE-BY-SIDE OPERABLE/FIXED WINDOWS**

SCALE: 3/4"=1'-0"  
(FOR INDIVIDUAL WINDOW INSTALLATION & DETAILS, SEE SINGLE WINDOW ELEVATIONS)  
(TRIPLE WINDOW SHOWN. MORE THAN 3 WINDOWS MAY BE COMBINED  
HORIZONTALLY IN ONE OPENING IN ANY COMBINATION OF FIXED & OPERABLE)  
NOTE: FOR FIXED TO FIXED, SEE DRAWING 1404 UNDER SEPARATE APPROVAL

FOR INFORMATION NOT SHOWN, SEE SINGLE  
WINDOW ELEVATIONS ON SHEET 1

ALLOWABLE DESIGN PRESSURE (SIDE-BY-SIDE & SINGLE WINDOW WITH TRANSOM)
MULLED UNIT ALLOWABLE DESIGN PRESSURE & INDIVIDUAL WINDOW SIZES WITHIN A MULLED UNIT SHALL BE LIMITED BY THE INDIVIDUAL WINDOW REQUIREMENTS AS SPECIFIED IN THE ALLOWABLE DESIGN PRESSURE TABLE ON SHEET 1.

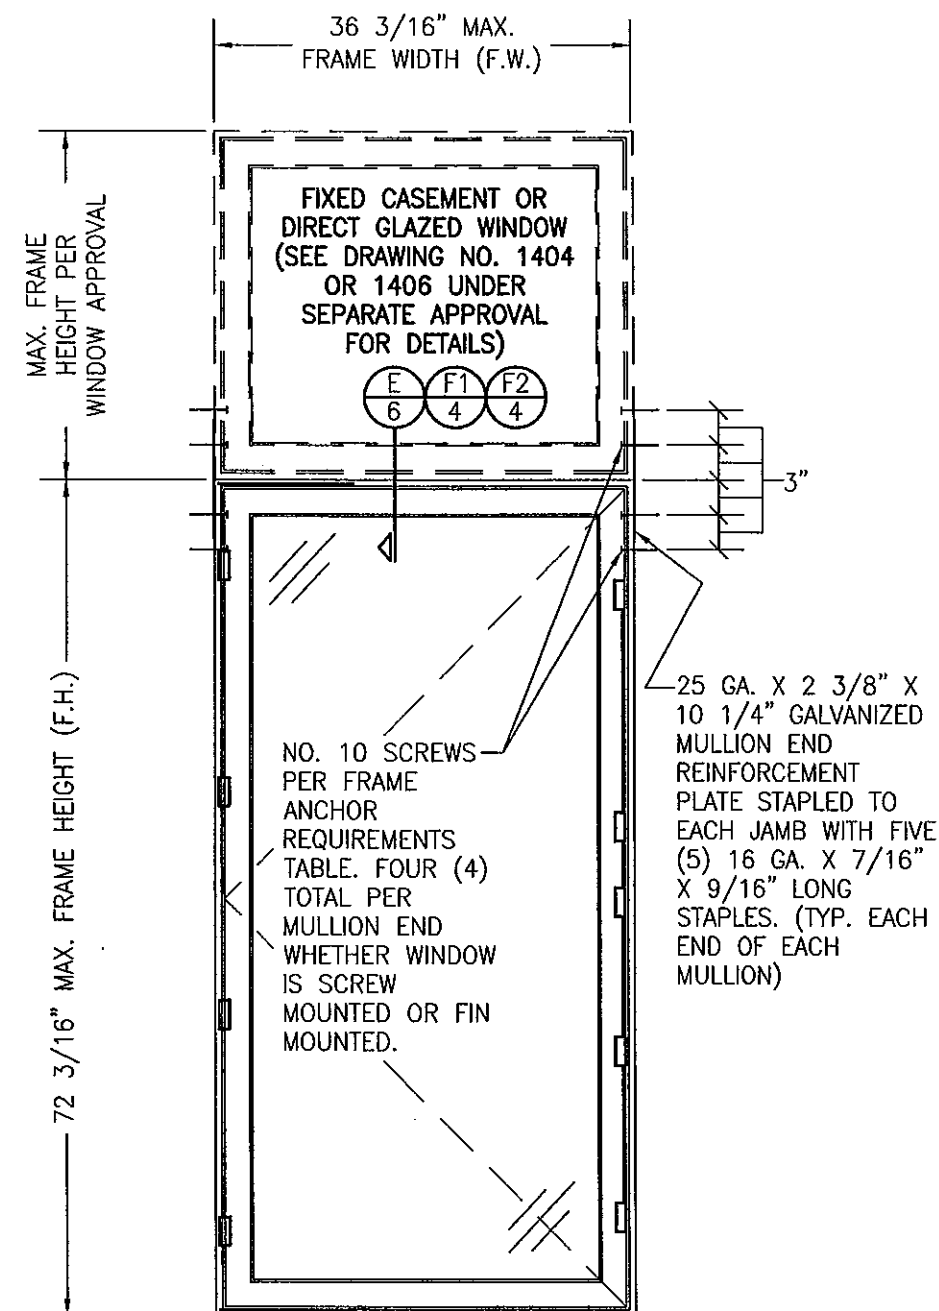


**EXTERIOR ELEVATION  
SINGLE WINDOW WITH TRANSOM**


SCALE: 3/4"=1'-0"  
(FOR INDIVIDUAL WINDOW INSTALLATION & DETAILS, SEE SINGLE WINDOW ELEVATIONS)

FOR INFORMATION NOT SHOWN, SEE SINGLE  
WINDOW ELEVATIONS ON SHEET 1

PRODUCT REVISED  
as complying with the Florida  
Building Code  
Acceptance No 11-1006-05  
Expiration Date June 29, 2016  
By *Manuel Perez*  
Miami Dade Product Control

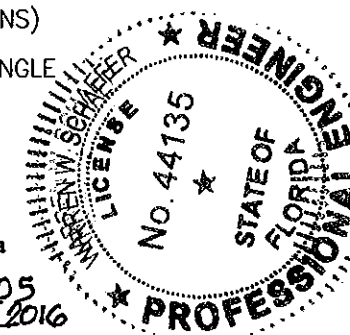

DRAWN BY: S.T.R.		CHECKED BY: W.W.S.	
PLOT: 1=16		DATE: 7/21/05	
NO.	DATE	BY	REVISION DESCRIPTION
DRAWING TITLE FEEL SAFE ALUMINUM CLAD WOOD IMPACT OPERABLE CASEMENT WINDOW		MANUFACTURER HWD ACQUISITION, INC. dba HURD WINDOWS & DOORS 575 S. WHELEN AVE. MEDFORD, WI 54451 800-433-4873	
CONSULTANTS W. W. SCHAEFER ENGINEERING & CONSULTING, P.A. (CA 6809) 7480 150TH COURT NORTH PALM BEACH GARDENS, FL 33418 PHONE: 561-744-3424		P.E. NO. 44135 WARREN W. SCHAEFER, P.E.	
DRAWING NO. 1403		REV. C	
SHEET NO. 2 OF 6			

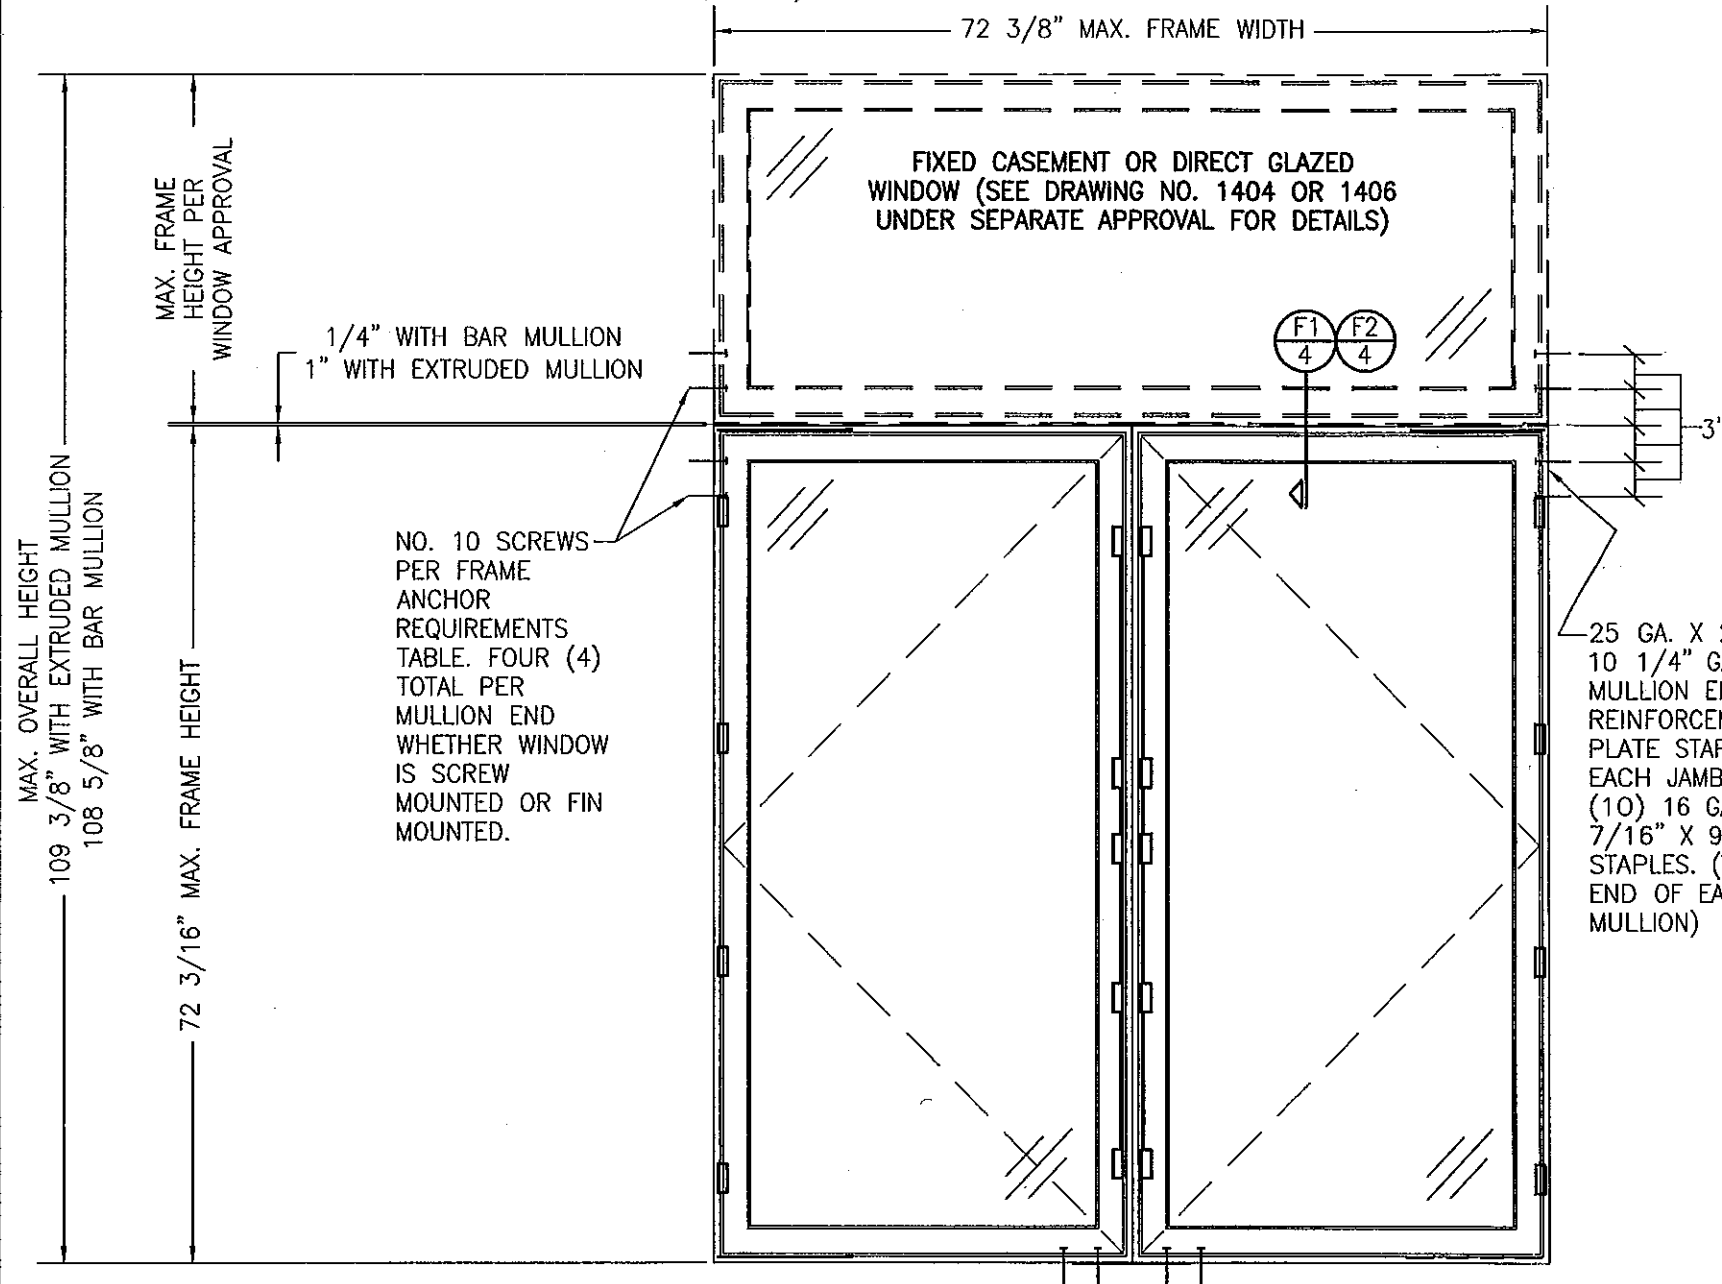

EXTERIOR ELEVATION  
TWIN WINDOW WITH TRANSOM

SCALE: 3/4"=1'-0"

ELEVATION NOTES:


1. FOR INDIVIDUAL WINDOW INSTALLATION & DETAILS, SEE SINGLE WINDOW ELEVATIONS.
2. TWIN WINDOWS ARE SHOWN AS "XX". "XO" WINDOW ALSO APPLIES WITH "O" WINDOW BEING A FIXED CASEMENT WINDOW UNDER SEPARATE APPROVAL DRAWING NO. 1404

ALLOWABLE DESIGN PRESSURE  
(TWIN WINDOW WITH TRANSOM)

AS CONTROLLED BY THE INDIVIDUAL WINDOW ALLOWABLE PRESSURES (NOT TO EXCEED +65/-70 PSF)

SEE GLASS OPTIONS  
1, 2, & 3 BELOW

SEE 2-PIECE  
DETAIL BELOW  
FOR INFORMATION  
NOT SHOWN

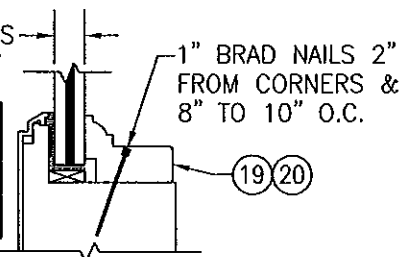

NON-I.G. GLAZING DETAIL WITH  
1-PIECE GLAZING BEAD

SEE GLASS OPTIONS  
1, 2, & 3 BELOW

TREMCO S900  
SILICONE AT EXTERIOR  
& GLASS EDGE

1/16" SHIM AS  
REQUIRED

1/8" THICK SHIMS  
AS REQUIRED

1" BRAD NAILS 2" FROM CORNERS & 8" TO 10" O.C.

9/16" MIN. BITE

(14) (15) (11) (10)

NON-I.G. GLAZING DETAIL WITH  
2-PIECE GLAZING BEAD

OPTION 1: 3/8" LAMINATED GLASS BY OLDCASTLE (5/32" AN/0.09 SOLUTIA SAFLEX IIIIG PVB/5/32" AN)

OPTION 2: 9/16" LAMINATED GLASS BY OLDCASTLE (1/4" AN/0.075 OLDCASTLE STORM GLASS/1/4" AN)

OPTION 3: 9/16" LAMINATED GLASS BY OLDCASTLE (1/4" AN/0.09 SOLUTIA SAFLEX IIIIG PVB/1/4" AN)

SEE GLASS OPTION  
4 BELOW

TREMCO S900 SILICONE AT  
EXTERIOR & GLASS EDGE

9/16" MIN. BITE

1/16" SHIM AS REQUIRED

1/8" THICK SHIMS  
AS REQUIRED

1" BRAD NAILS 2" FROM CORNERS & 8" TO 10" O.C.

(14) (15) (21) (10)


TYPICAL I.G. GLAZING DETAIL

OPTION 4: 7/8" LAMINATED I.G. BY OLDCASTLE (1/8" AN/0.09 SOLUTIA SAFLEX IIIIG PVB/1/8" AN. EXTERIOR 7/16" SPACER; 1/8" TEMP. INTERIOR)





PRODUCT REVISED  
as complying with the Florida  
Building Code

Acceptance No. 11-1006.05  
Expiration Date June 29, 2016



By *Manuel Perez*  
Miami Dade Product Control

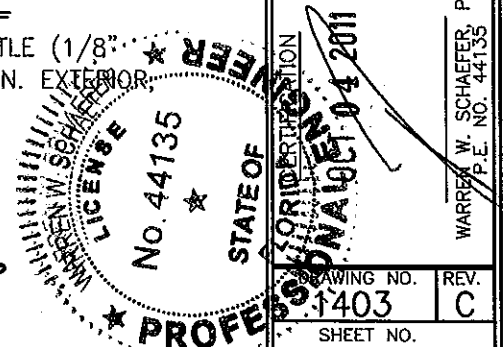

DRAWN BY: S.T.R.	CHECKED BY: W.W.S.
PLOT: 1=16	DATE: 7/21/05
NO.	DATE
BY	
REVISION DESCRIPTION	
NO.	
DRAWING TITLE FEEL SAFE ALUMINUM CLAD WOOD IMPACT OPERABLE CASEMENT WINDOW	MANUFACTURER HWD ACQUISITION, INC. dba HURD WINDOWS & DOORS 575 S. WHELEN AVE. MEDFORD, WI 54451 800-433-4873
CONSULTANTS W. W. SCHAEFER ENGINEERING & CONSULTING, P.A. (CA 6809)	7480 150TH COURT NORTH PALM BEACH GARDENS, FL 33418 PHONE: 561-744-3424
WARREN W. SCHAEFER, P.E. P.E. NO. 44135	
DRAWING NO. 1403	REV. C
SHEET NO. 3 OF 6	

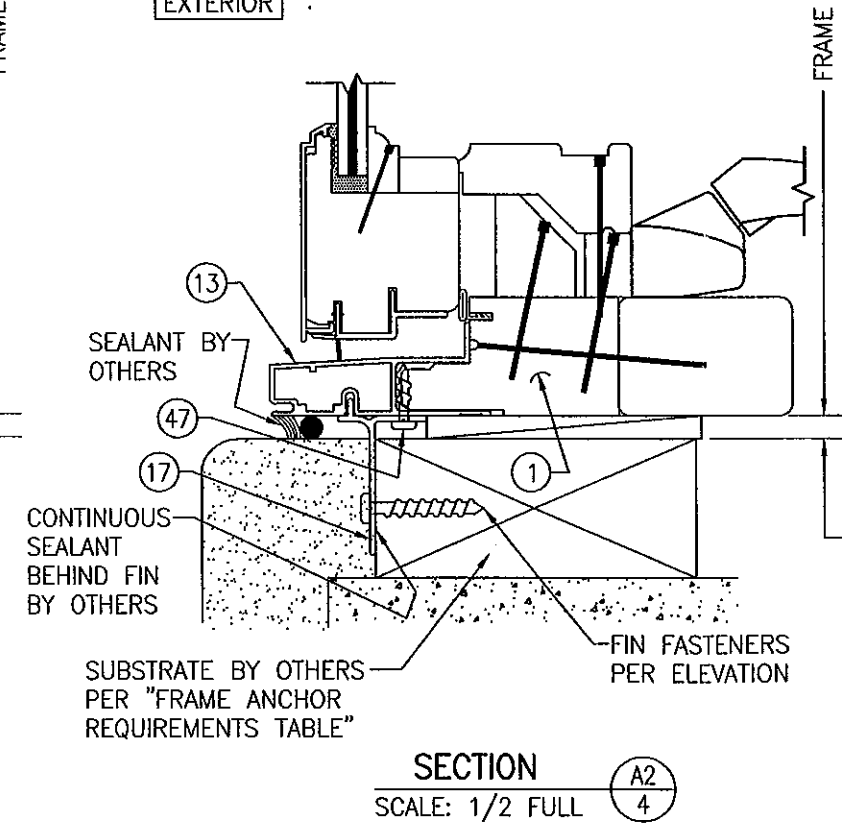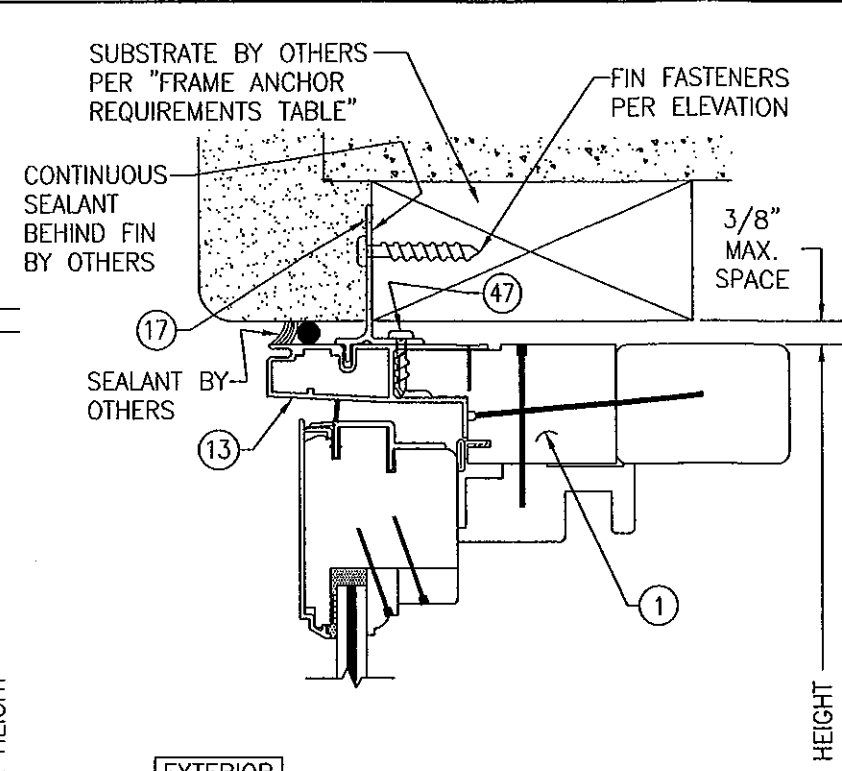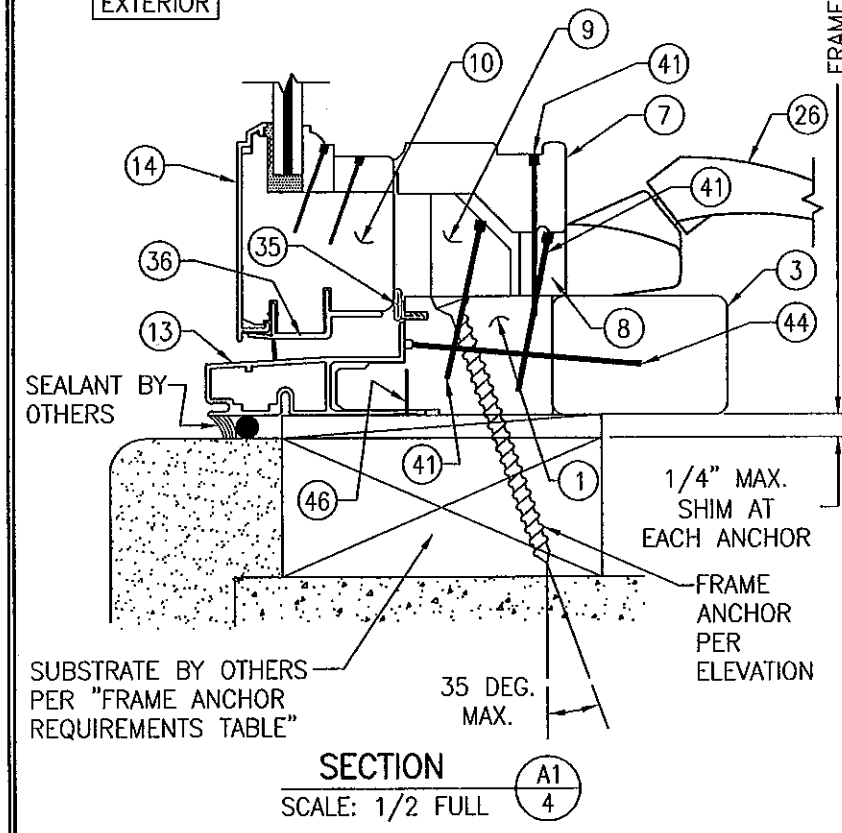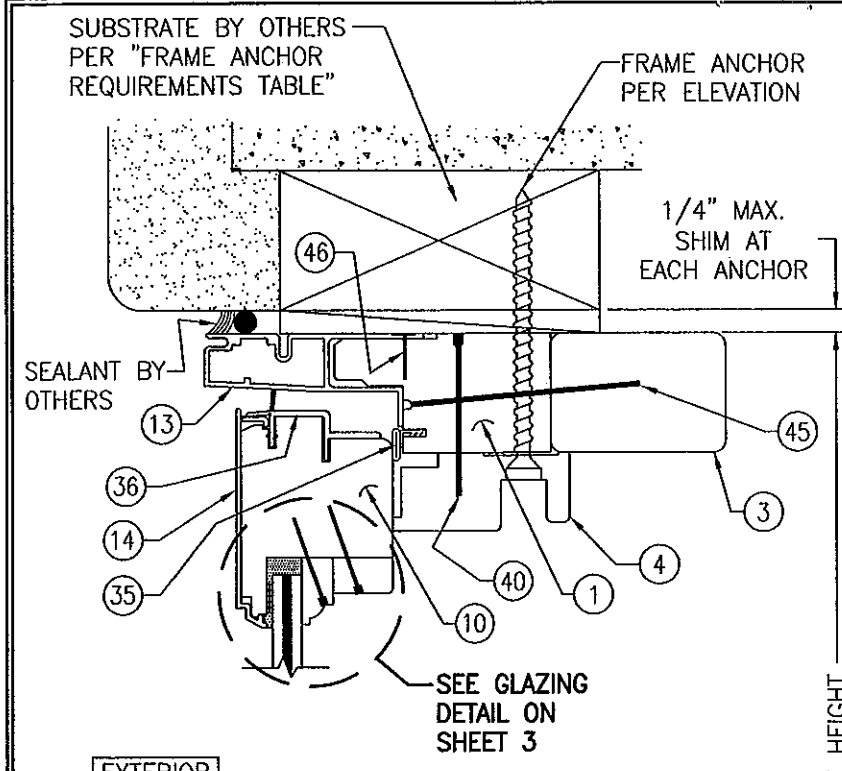





(SEE SECTION A1/4 FOR DETAILS NOT SHOWN)

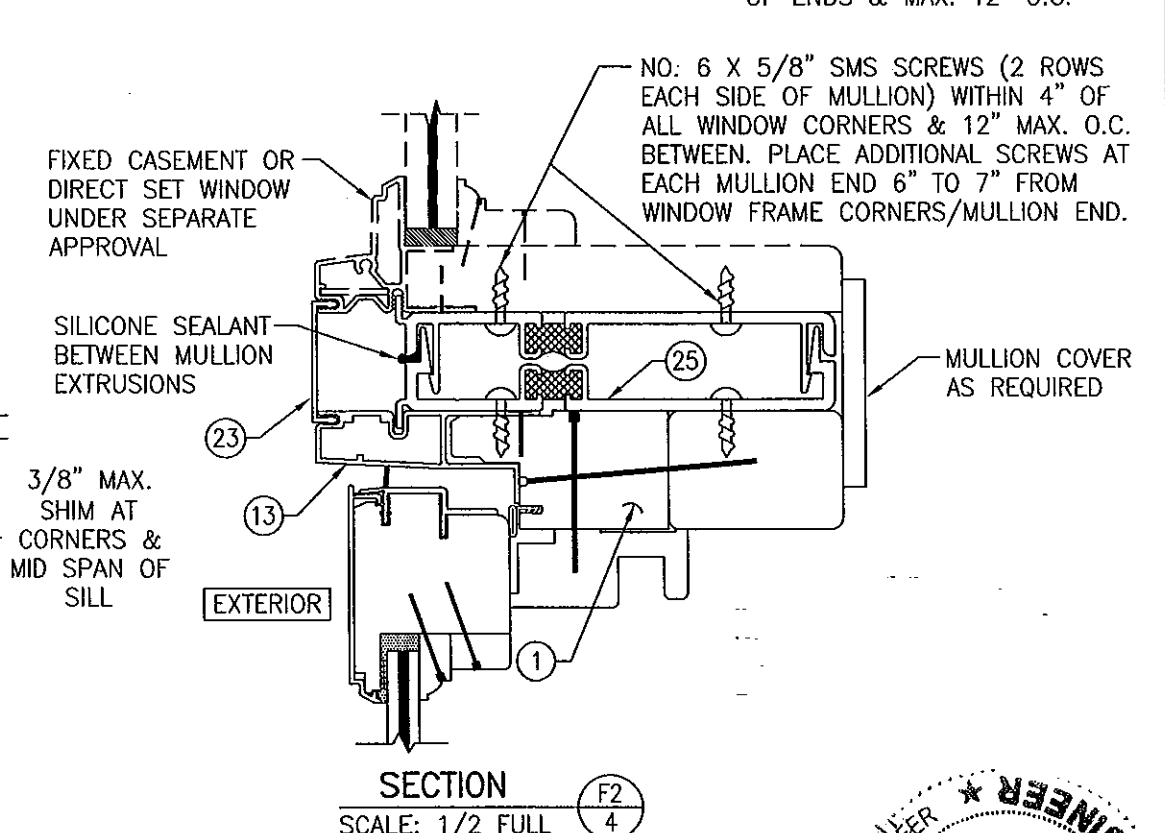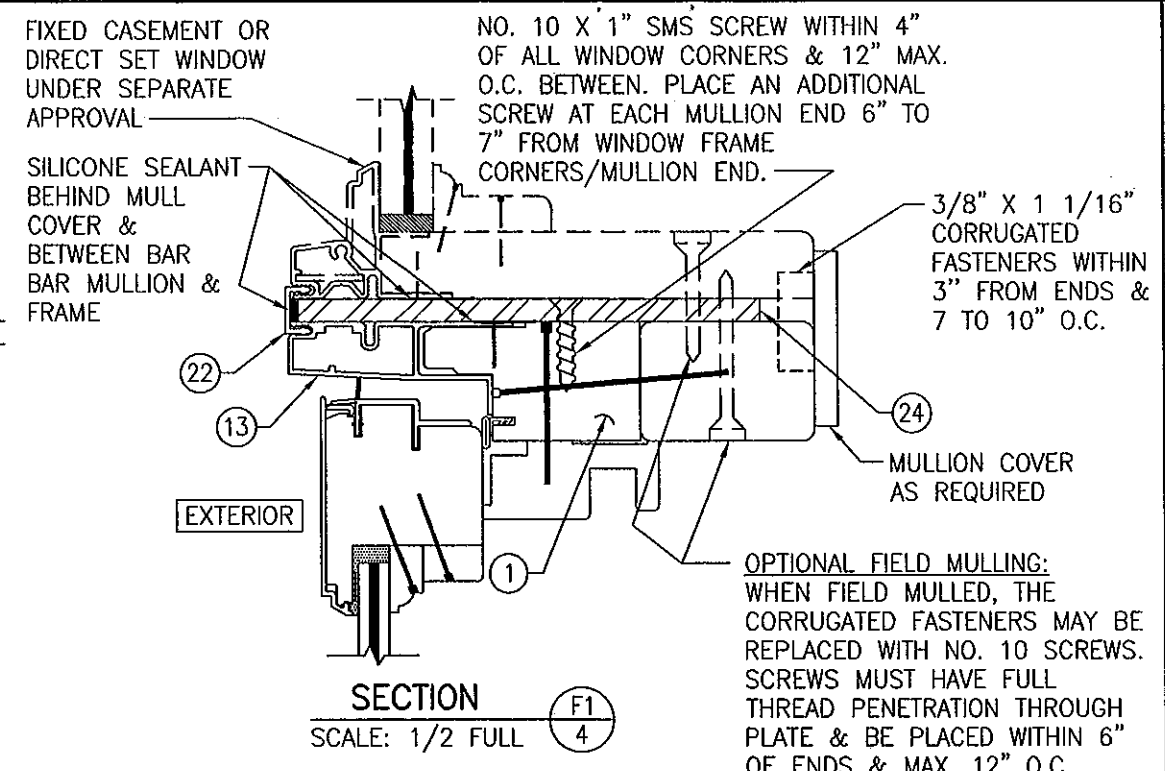

PRODUCT REVISED  
as complying with the Florida  
Building Code  
Acceptance No. 11-1006.05  
Expiration Date June 29, 2016  
By *Warren W. Schaefer*  
Miami Dade Product Control



DRAWN BY: S.T.R.	CHECKED BY: W.W.S.
PLOT: 1-2	DATE: 7/21/05
DATE	BY
REVISION DESCRIPTION	NO.
DRAWING TITLE FEEL SAFE ALUMINUM CLAD WOOD IMPACT OPERABLE CASEMENT WINDOW	
MANUFACTURER HWD ACQUISITION, INC. dba HURD WINDOWS & DOORS 575 S. WHELEN AVE. MEDFORD, WI 54451 800-433-4873	
CONSULTANTS W. W. SCHAEFER ENGINEERING & CONSULTING, P.A. (CA 6809) 7480 150TH COURT NORTH PALM BEACH GARDENS, FL 33418 PHONE: 561-744-3424	
CERTIFICATION	OCT 04 2011
DRAWING NO. 1403	REV. C
SHEET NO. 4	OF 6

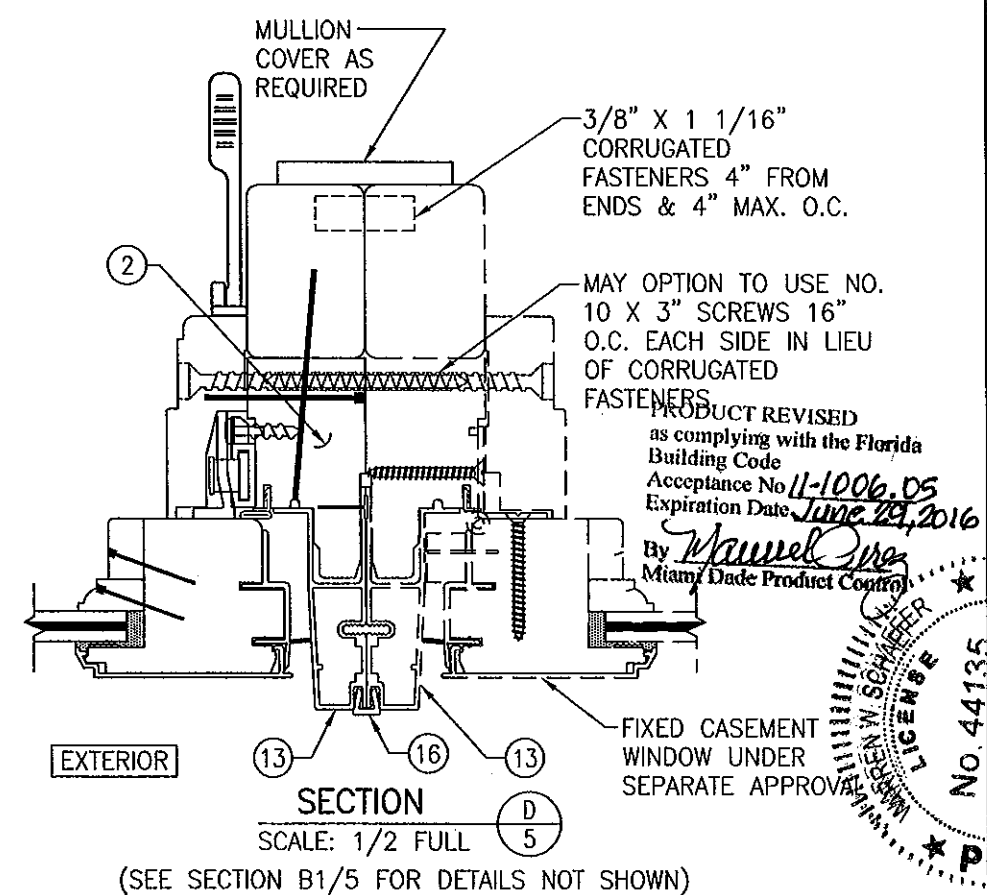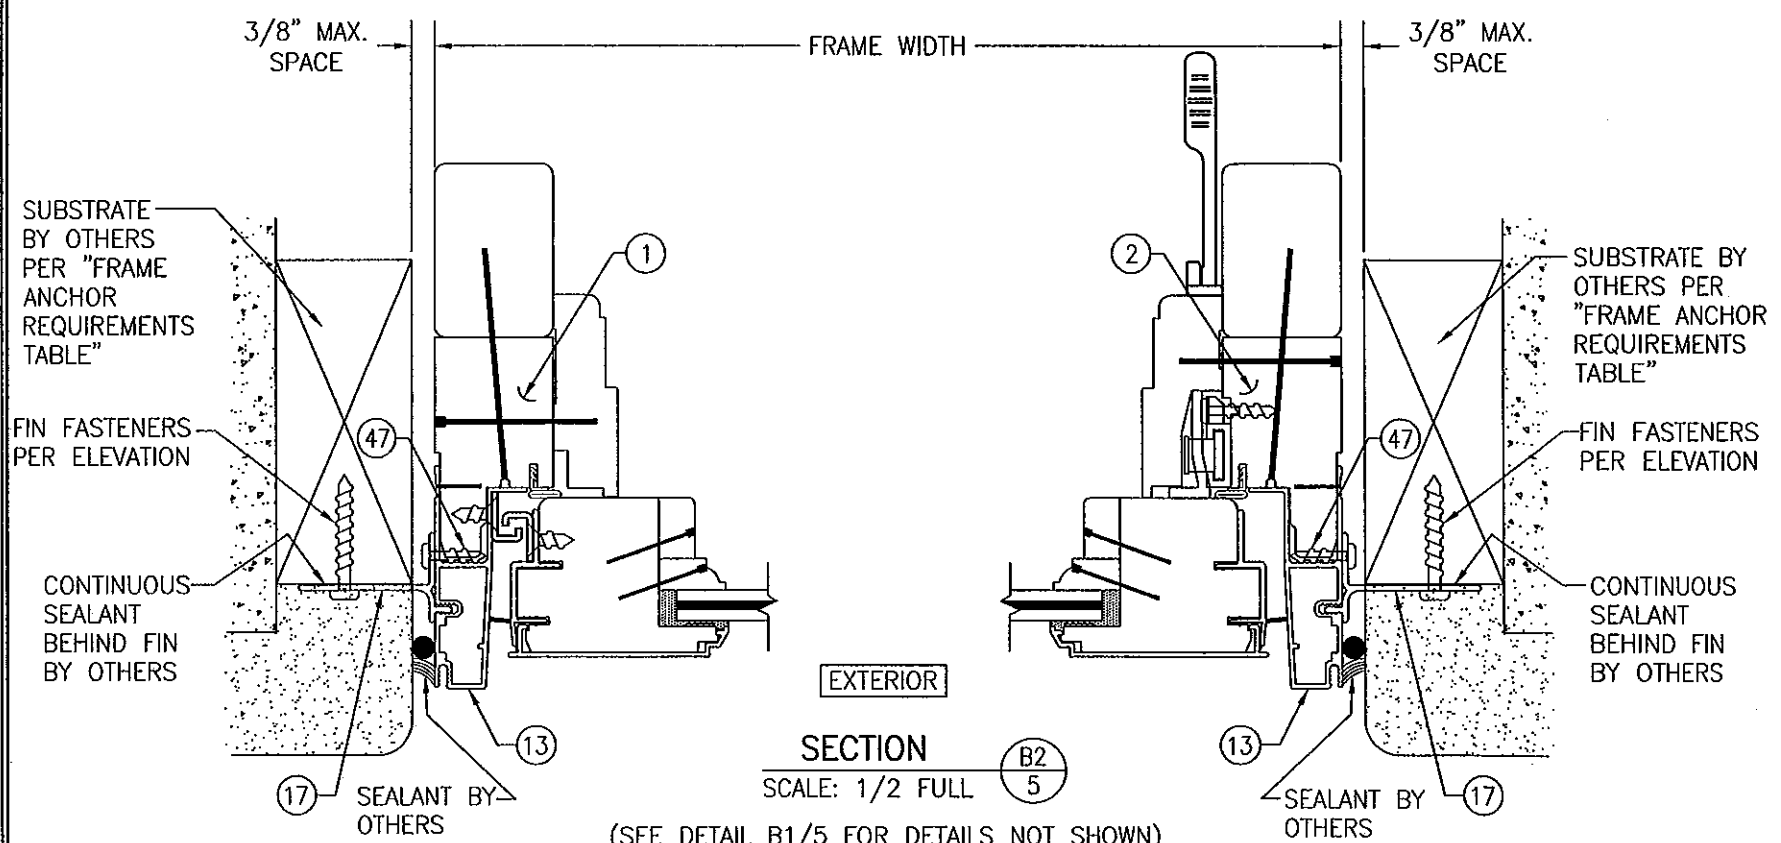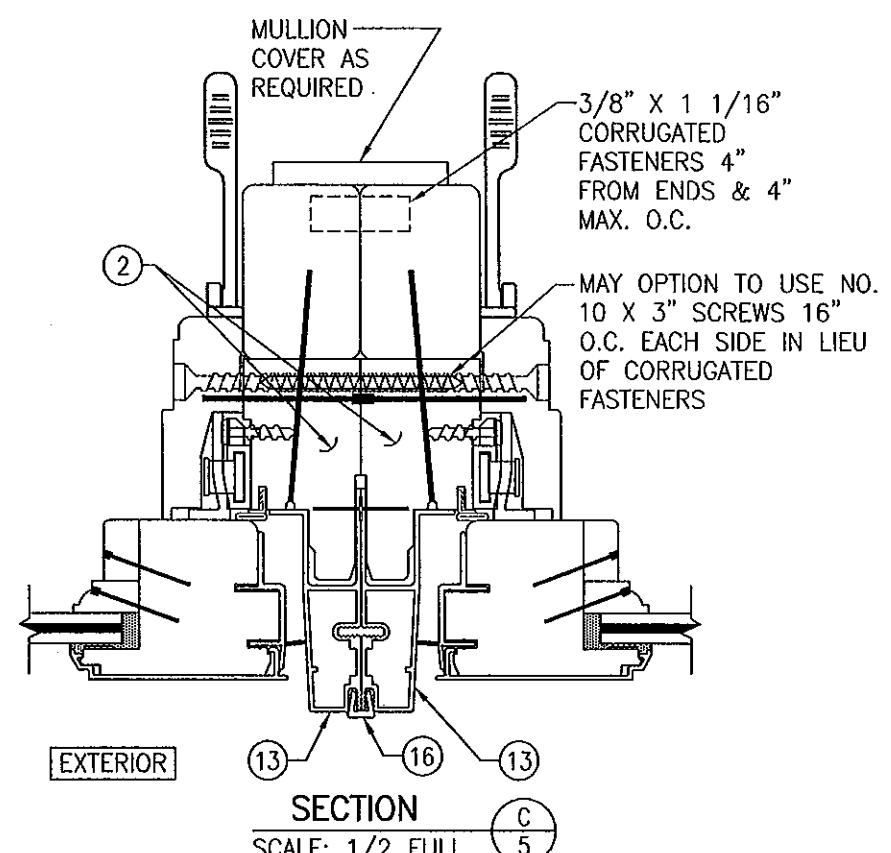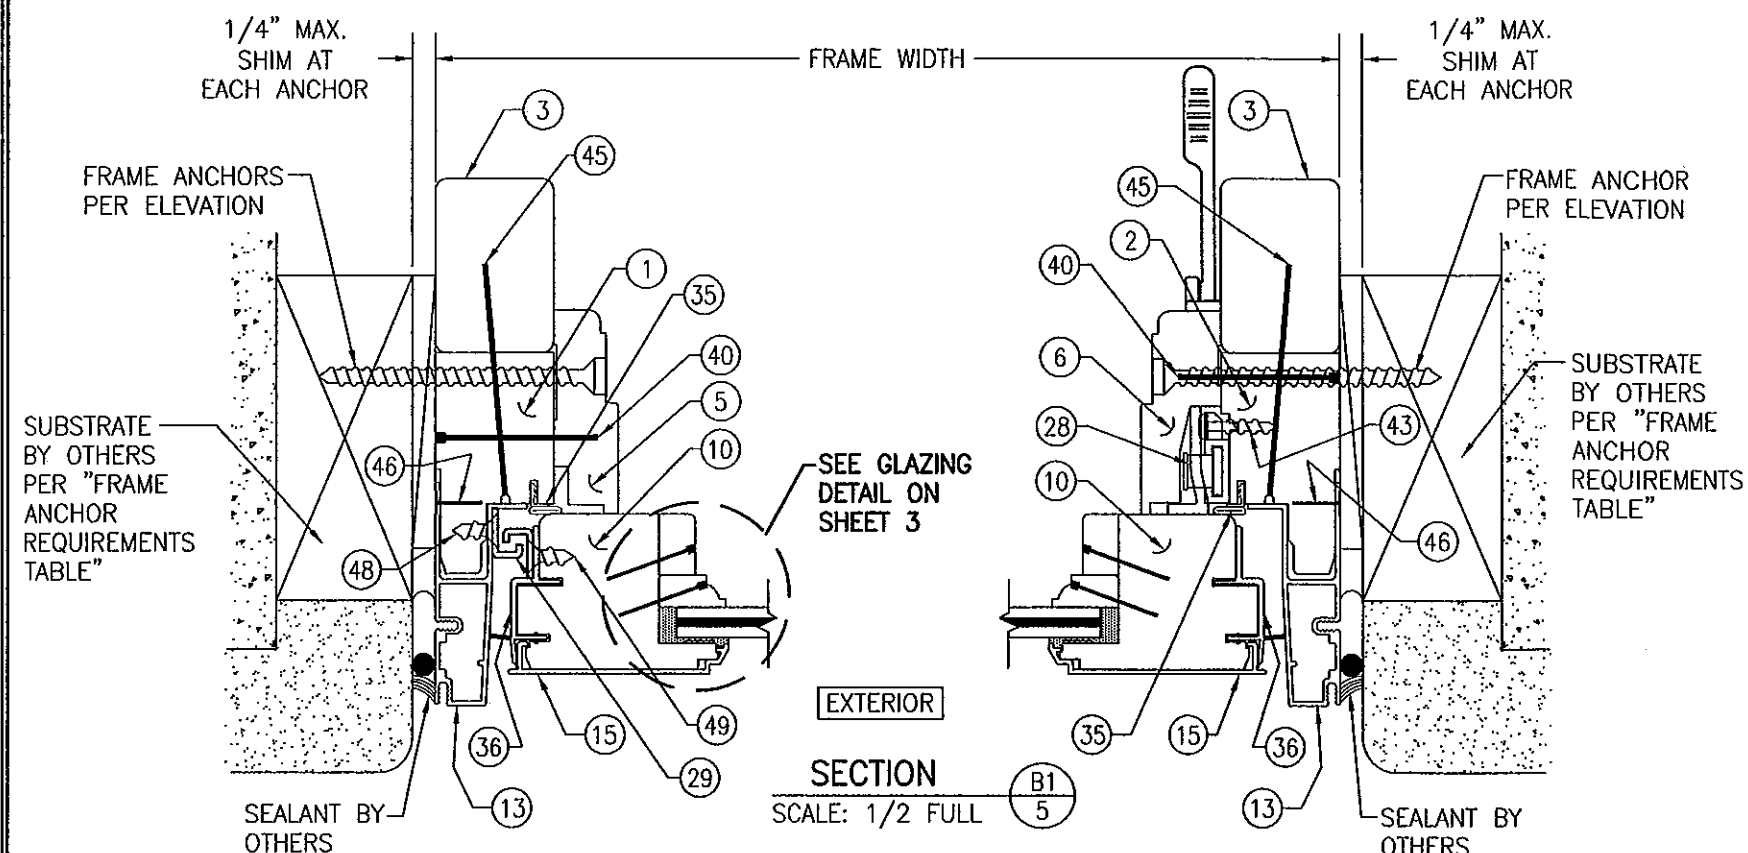

DRAWN BY: S.T.R.	CHECKED BY: W.W.S.
PLOT: 1=2	DATE: 7/21/05
DATE	BY
REVISION DESCRIPTION	
NO.	
DRAWING TITLE <b>FEEL SAFE ALUMINUM CLAD WOOD IMPACT OPERABLE CASEMENT WINDOW</b>	
MANUFACTURER	<b>HWD ACQUISITION, INC. dba HURD WINDOWS &amp; DOORS</b> 575 S. WHELEN AVE. MEDFORD, WI 54451 800-433-4873
CONSULTANTS	<b>W. SCHAEFER ENGINEERING &amp; CONSULTING, P.A. (CA 6809)</b> 7480 150TH COURT NORTH PALM BEACH GARDENS, FL 33418 PHONE: 561-744-3424
CERTIFICATION	No. 44135 STATE OF FLORIDA PROFESSIONAL ENGINEER WARREN W. SCHAEFER, P.E. P.E. NO. 44135
DRAWING NO.	1403
REV.	C
SHEET NO.	5 OF 6



